


REVISIONS DATE FOR 51EC INC. 31 NORTH TEJON ST, SUITE 304 COLORADO SPRINGS, CO 80903 FIFTYONEEC.COM T 719.368.7394 EL F JAIL LEGEND, NOTES AND **SPECIFICATIONS**

SHEET NO:

P-001

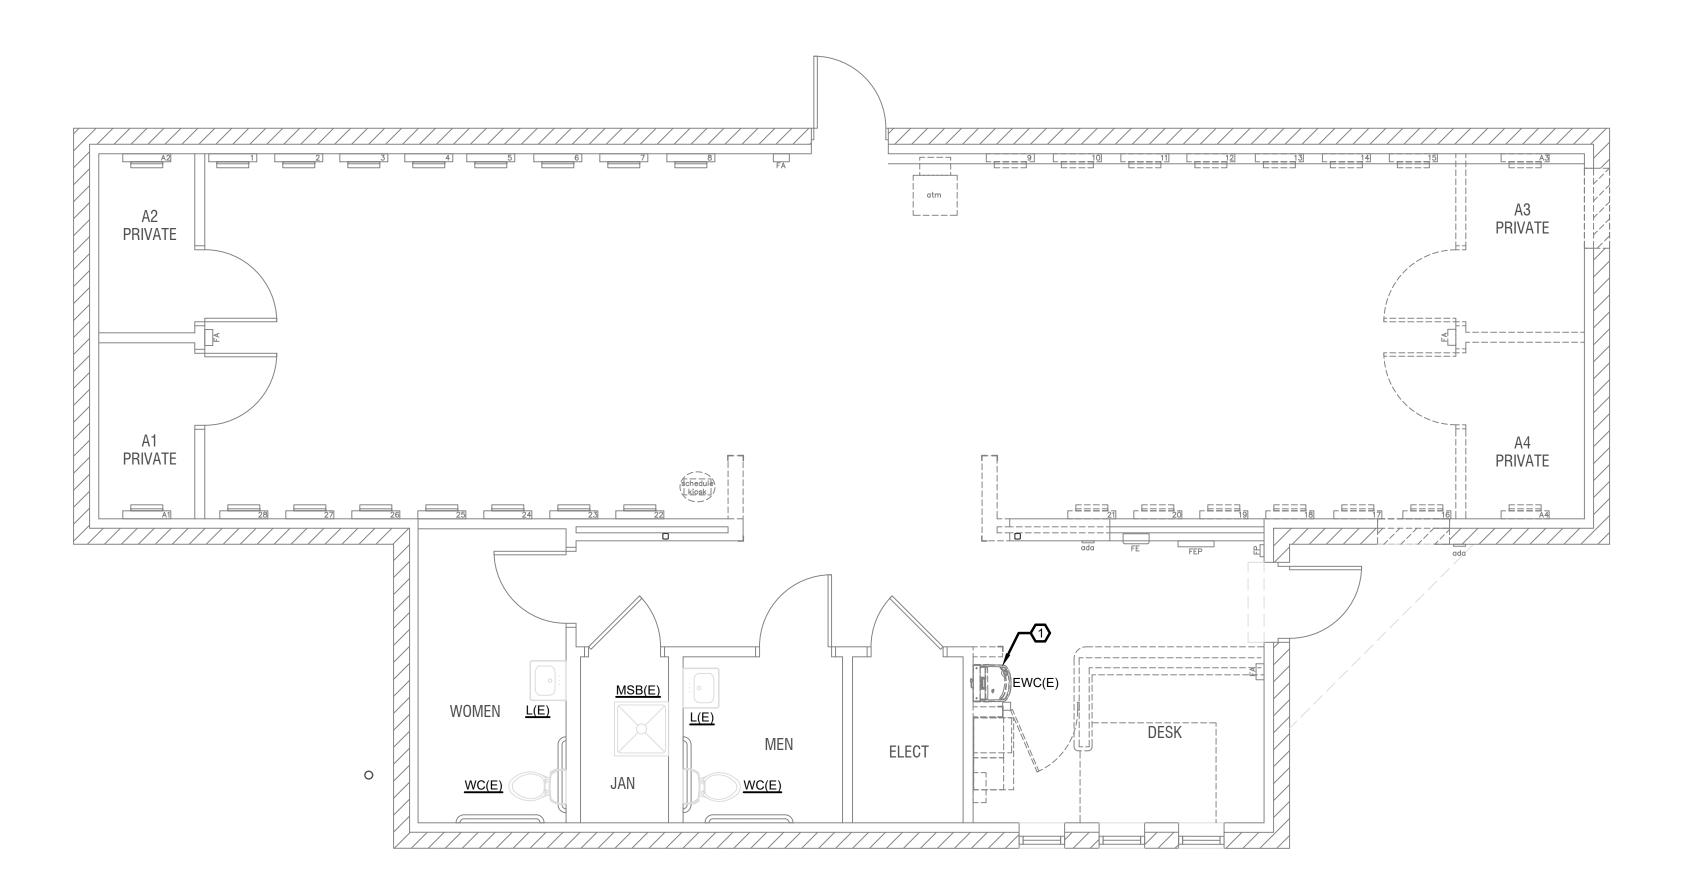

GENERAL NOTES:

EXISTING LAYOUT AND ROUTING HAVE BEEN COMPLETED TO THE BEST OF THE ENGINEER'S ABILITY. SHOULD EXISTING CONDITIONS DIFFER FROM LAYOUT SHOWN, CONTRACTOR SHALL NOTIFY AND COORDINATE WITH ENGINEER TO ADDRESS ANY DISCREPANCIES.

FIELD VERIFY EXACT LOCATION OF EXISTING WATER PIPE PRIOR TO COMMENCING WORK. PRESUMED LOCATION OF EXISTING WATERLINE. ACTUAL CONDITIONS UNKNOWN AND NOT OBSERVABLE.

DEMOLITION KEY NOTES:

REMOVE EXISTING DRINKING FOUNTAIN AND CAP EXISTING 1/2" COLD WATER, AND EXISTING 2" WASTE, TO BE CONNECTED TO NEW DRINKING FOUNTAIN.

WATER PIPING & WASTE/VENT DEMOLITION PLAN

SCALE: 1/4" = 1'-0"

REVISIONS
DATE FOR



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31 NORTH TEJON ST, SUITE 304 COLORADO SPRINGS, CO 80903 FIFTYONEEC.COM T 719.368.7394

DG Architecture

PASO COUNTY 20 CO

AL PASO COUNTY
ALL VISITOR CENTER
ADEO VISITATION REMODEL
A27 E. LAS VEGAS STREET

WATER PIPING &
WASTE/VENT
DEMOLITION PLAN


DATE: 01/04/22

DRAWN BY: JLV

CHECKED BY: AIS

PROJECT NO: 5136-21-09
SHEET NO:

PD-W-101

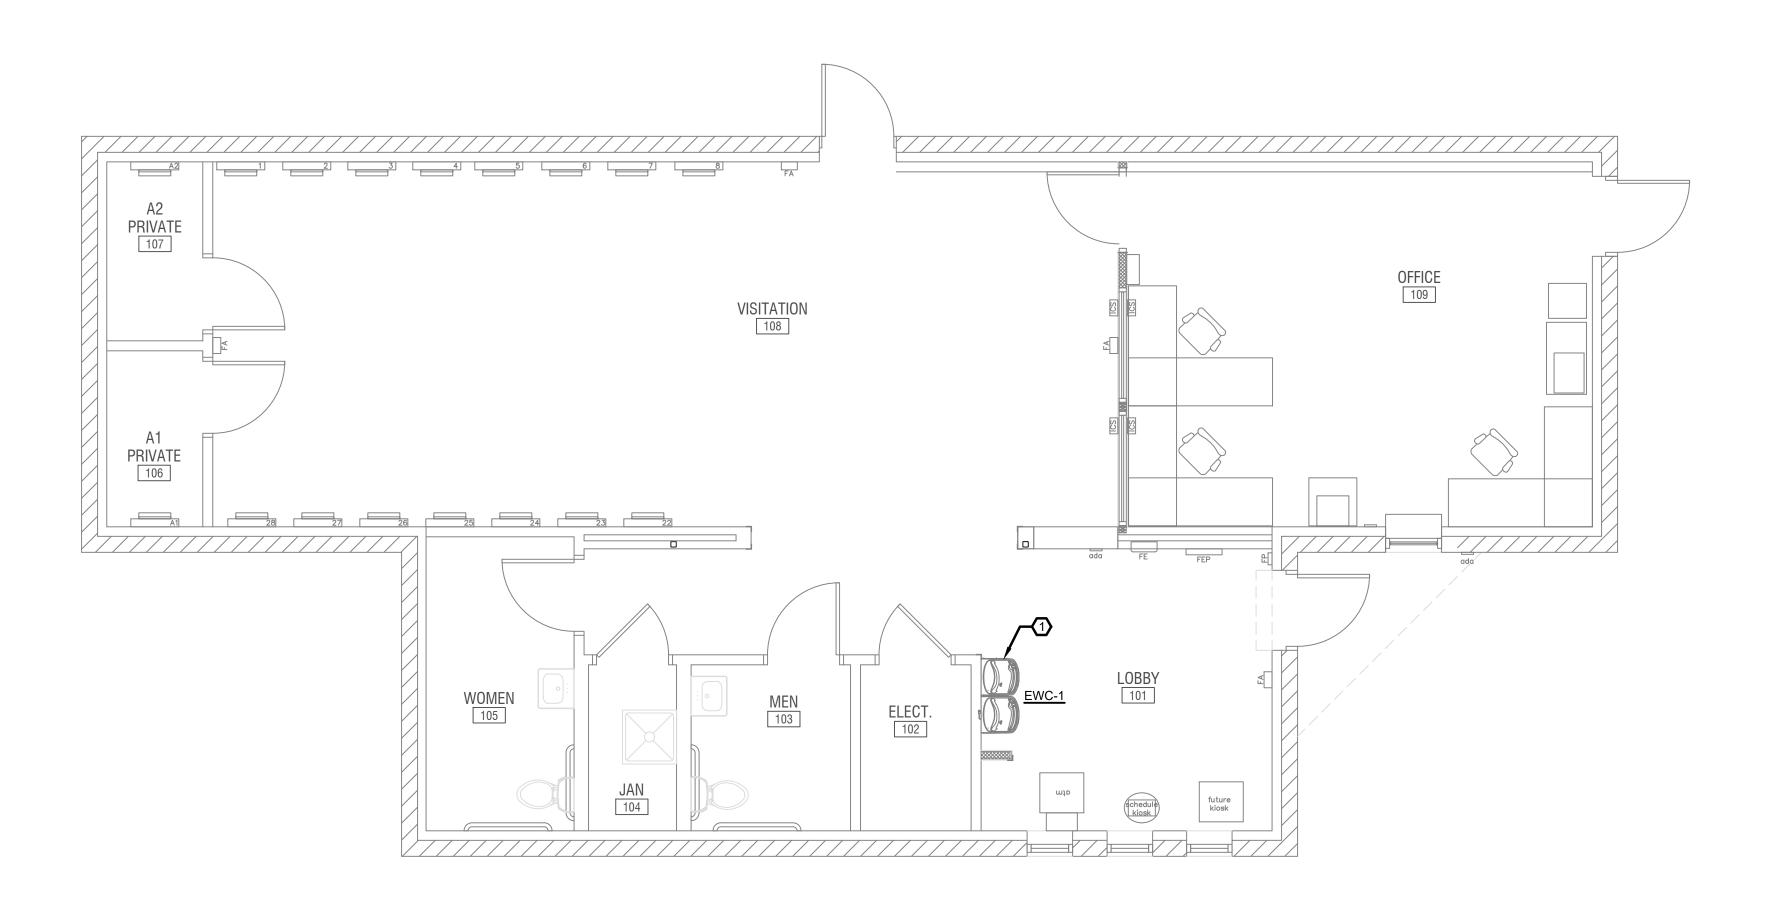

GENERAL NOTES:

ALL PIPING PENETRATIONS THROUGH RATED ASSEMBLIES ARE TO BE SEALED AND PROTECTED BY FIRE RESISTANT CAULKING.


NEW WORK KEY NOTES:

CONNECT <u>EWC-1</u> TO EXISTING 1/2" COLD WATER AND EXISTING 2" WASTE.

WATER PIPING & WASTE/VENT NEW WORK PLAN

SCALE: 1/4" = 1'-0"

DATE FOR

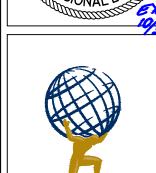

51EC INC.

31 NORTH TEJON ST, SUITE 304 COLORADO SPRINGS, CO 80903 FIFTYONEEC.COM T 719.368.7394

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WATER PIPING & WASTE/VENT NEW WORK PLAN

DATE: 01/04/22

CHECKED BY: AIS PROJECT NO: 5136-21-09

WATER PIPE SIZE ANALYSIS

WATER SUPPLY FIXTURE UNITS (WSFU	J) - PER 2015 IP	C TABLE 103.3(2)		
FIXTURE	QTY	WSFU	TOTAL	
WATER CLOSET (FLUSH VALVE)	2	10.00	20.00	
LAVATORY	2	2.00	4.00	
SERVICE SINK / MOP SINK BASIN	1	3.00	3.00	
DRINKING FOUNTAIN	1	0.25	0.25	
	TOTAL	FIXTURE UNITS	27.25	
FLOW RATE INFORMATION				
DOMESTIC FLOW RATE PER 2015 IPC TABLE E103.3(3	B) [GPM]		10.0	
IRRIGATION FLOW RATE PER LANDSCAPING CONTRA	ACTOR [GPM]		10.0	
TOTAL SYSTEM FLOW RATE [GPM]			20.0	
SERVICE PRESSURE				
MAXIMUM STATIC PRESSURE AVAILABLE AT THE DOMESTIC WATER ENTRY (PER 2015 IPC SECTION 604.8, DOWNSTREAM OF THE REQUIRED PRESSURE REGULATOR) [PSI]			80	
SYSTEM LOSSES				
METER LOSS [PSI]				
LOSS THROUGH RPZ BACFLOW PREVENTER [PSIG]				
STATIC HEAD LOSS DUE TO ELEVATION (VERTICAL LENGTH * 0.43 PSIG/FT) [PSI]				
LOSS IN HORIZONTAL LENGTH OF PIPING (LONGEST DISTANCE) [FT] * (1.2) [FITTING FACTOR] [FT]				
DISTRIBUTION PIPE LOSSES PER FIGURE E103.3(3) (LONGEST LENGTH OF PIPING) * (PRESSURE DROP / 100 FT) [PSI]			0.5	
TOTAL PRESSURE LOSSES FOR	THE PROPOSED	SYSTEM [PSI]	28.93	
MINIMUM PRESSURE REQUIRED FOR PROPER FIXTURE OPERATION (PER 2015 IPC TABLE 604.3) [PSI]			20	
TOTAL SYSTEM PRESSURE REQUIREMENT FOR THE PROPOSED SYSTEM (LOSSES) + (FIXTURE REQUIREMENTS) [PSI]			48.93	
NET POSITIVE SYSTEM PRESSURE AVAILABLE (MAXIMUM STATIC PRESSURE) - (SYSTEM PRESSURE REQUIREMENT) [PSI]			31.07	

DISTRIBUTION PIPING. IN ORDER TO ACCOMMODATE THE DEMAND ON THE DOMESTIC WATER SYSTEM IMPOSED BY THE FIXTURES IN THIS CONTRACT,
THE EXISTING WATER METER AND DISTRIBUTION PIPING MAY BE RE-USED.

PLUMBING FIXTURE SCHEDULE

MARK	DESCRIPTION	WASTE	VENT	COLD	НОТ
WC(E)	WATER CLOSET (ADA COMPLIANT) (EXISTING) KOHLER NO. K-4368	EXISTING	EXISTING	EXISTING	
L(E)	LAVATORY (ADA COMPLIANT, WALL-MOUNT) (EXISTING) KOHLER NO. K-2005	EXISTING	EXISTING	EXISTING	EXISTING
EWC-1	ELECTRIC WATER COOLER (TWO-LEVEL, ADA COMPLIANT) EQUAL TO ELKAY MODEL #EZSTL8LC, TWO-LEVEL DRINKING FOUNTAIN (ADA COMPLIANT), LIGHT GRAY, INCLUDING ELECTRONIC BUBBLER PUSHBARS, FLEXI-GUARD BUBBLERS, 8 GPH CHILLING, AND 115V/1Ø, 5A FLA, RATED AT 370 WATTS. INSTALL WITH 20A MOCP AND GFCI PROTECTION. INCLUDE WALL PLATE ACCESSORY #1000004539.	2"	1-1/2"	1/2"	
MSB(E)	MOP SINK (EXISTING) FIAT NO. MSB-2424	EXISTING	EXISTING	EXISTING	EXISTING

PIPE INSULATION SCHEDULE

FLUID OPERATING TEMPERATURE RANGE AND USAGE (°F)	INSULATION CONDUCTIVITY		NOMINAL PIPING SIZE			
	(BTU * IN.) (H * FT ² * °F) ^b	MEAN RATING TEMP, °F	< 1"	1" TO < 1-1/2"	1-1/2" TO < 4"	4" TO < 8"
> 350	0.32 - 0.34	250	4.5"	5.0"	5.0"	5.0"
251 - 350	0.29 - 0.32	200	3.0"	4.0"	4.5"	4.5"
201 - 250	0.27 - 0.30	150	2.5"	2.5"	2.5"	3.0"
141 - 200	0.25 - 0.29	125	1.5"	1.5"	2.0"	2.0"
105 - 140	0.21 - 0.28	100	1.0"	1.0"	1.5"	1.5"
40 - 60	0.21 - 0.27	75	0.5"	0.5"	1.0"	1.0"
< 40	0.20 - 0.26	50	0.5"	1.0"	1.0"	1.0"

PIPING MATERIALS SCHEDULE

ALL PIPE AND FITTINGS LISTED ARE ONLY TO BE USED WHERE PERMITTED BY CODE				
SANITARY WASTE & VENT (W & V)	SCHEDULE 10 CAST IRON WITH NO HUB OR BANDED CONNECTIONS AND FITTINGS			
	ALTERNATE: SCHEDULE 40 PVC, WITH PRIMED AND GLUED CONNECTIONS AND FITTINGS			
DOMESTIC COLD WATER (CW) DOMESTIC HOT WATER (HW) HOT WATER RECIRCULATION (HWC)	TYPE "L" COPPER PIPING, WITH SOLDERED OR BRAZED FITTINGS. SOFT COPPER UNDERSLAB WITH NO JOINTS.			
	ALTERNATE: PEX TUBING WITH BANDED CONNECTIONS AND FITTINGS			
DRAINAGE (ORDL & RDL)	SCHEDULE 40 PVC, PRIMED AND GLUED OR THREADED CONNECTIONS AND FITTINGS.			

REVISIONS

DATE FOR





51EC INC.
31 NORTH TEJON ST, SUITE 304

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TDG Architectu



JAIL VISITUR CENTER
VIDEO VISITATION REMODEL
2727 E. LAS VEGAS STREET
COLORADO SPRINGS, CO

SCHEDULES AND CALCULATIONS

DATE: 01/04/22

DRAWN BY: JLV

CHECKED BY: AIS
PROJECT NO: 5136-2

SHEET NO:

P-601