GENERAL NOTES

CONTRACTOR, SUBCONTRACTORS AND SUPPLIERS SHALL REVIEW AND VERIFY ALL NOTES, DIMENSIONS AND INFORMATION ON THESE DRAWINGS PRIOR TO CONSTRUCTION AND REPORT ANY DISCREPANCIES, OMISSIONS OR CHANGES TO THE ARCHITECT. IF ERRORS, OMISSIONS, OR QUESTIONS REGARDING THE DRAWINGS BECOME EVIDENT OR ARE SUSPECTED, THE ITEM SHALL BE BROUGHT TO THE ATTENTION OF THE ARCHITECT IN WRITING PRIOR TO PROCEEDING WITH WORK. FAILURE TO DO SO SHALL RELIEVE THE ARCHITECT OF ANY LIABILITIES FOR ERRORS OR OMISSIONS IN THE PLANS.

THE CONTRACTOR SHALL VERIFY SITE CONDITIONS AND DIMENSIONS PRIOR TO STARTING ANY WORK. ANY DISCREPANCIES FROM THESE DRAWINGS SHALL BE BROUGHT TO THE ATTENTION OF THE ARCHITECT IN WRITING PRIOR TO PROCEEDING WITH WORK.

3. ALL WORK IS TO BE PERFORMED IN A THOROUGH AND GOOD MORKMANSHIP-LIKE MANNER BY SKILLED WORKERS IN CONFORMANCE WITH THE BEST STANDARDS OR PRACTICES IN THE TRADE.

4. ALL WORK SHALL COMPLY WITH APPLICABLE LOCAL, COUNTY, STATE AND FEDERAL CODES, ORDINANCES, RULES AND REGULATIONS THE CONSTRUCTION SITE SHALL BE MAINTAINED IN A CLEAN, ORDERLY AND SAFE MANNER. DEBRIS SHALL BE PLACED IN TRASH

RECEPTACLES OR BINS. FENCE OFF OPEN TRENCHES OR OTHER HAZARDS FROM TRESPASSERS. STORE VALUABLE MATERIALS, TOOLS, SUPPLIES OR APPLIANCES IN A LOCKED SPACE. CONFORM WITH BUILDING MANAGEMENT REGULATIONS FOR NOISE CONTROL, CLEAN-UP AND SITE CONDITIONS.

ALL FEDERAL AND STATE SAFETY AND OSHA REGULATIONS SHALL BE ENFORCED FOR ALL WORK, EQUIPMENT AND CONSTRUCTION METHODS. IF ASBESTOS OR ASBESTOS-CONTAINING MATERIALS ARE ENCOUNTERED DURING DEMOLITION OR CONSTRUCTION, STOP WORK AND DO NOT DISTURB THOSE MATERIALS. NOTIFY OWNER AND ARCHITECT WHO WILL CONSULT WITH A LICENSED ASBESTOS ABATEMENT PROFESSIONAL TO PROPERLY REMOVE THE MATERIALS PRIOR TO PROCEEDING. LIMITED ASBESTOS TESTING PERFORMED BY OWNER

PROVIDE TEMPORARY SHORING FOR THE EXISTING STRUCTURE DURING DEMOLITION UNTIL THE NEW SUPPORTING STRUCTURE IS IN PLACE. LOCATE AND STAKE ALL EXISTING UNDERGROUND UTILITY LINES PRIOR TO EXCAVATION, TRENCHING OR DIGGING. REPLACE OR REPAIR ANY

DAMAGE TO EXISTING LINES THAT MAY OCCUR. IO. FOR ADDITIONS AND REMODELS: HIDDEN CONDITIONS MAY EXIST AT THE TIME OF PREPARATION OF THE DRAWINGS. IF EXPOSURE OF THESE HIDDEN CONDITIONS RESULT IN CONFLICTS WITH THE DRAWINGS, THE ARCHITECT SHALL BE NOTIFIED IMMEDIATELY IN WRITING PRIOR TO

PROCEEDING WITH ANY WORK. II. ALL DIMENSIONS ARE FROM FACE OF NEW FRAMING, FACE OF EXISTING MASONRY, OR FACE OF FINISH ON EXISTING WALLS UNLESS NOTED OTHERWISE ON THE DRAWINGS.

12. ALL GLASS WITHIN 18" OF FLOOR AND WITHIN A 24" ARC OF DOOR JAMBS TO BE TEMPERED GLASS. ALL GLASS WITHIN DOORS ALSO SHALL BE TEMPERED.

13. ALL SMOKE DETECTORS SHALL BE PERMANENTLY WIRED AND

INTERCONNECTED WITH BATTERY BACKUP. ALL EXITS SHALL BE OPERABLE FROM THE INSIDE WITHOUT THE USE OF A KEY OR SPECIAL KNOWLEDGE. MANUALLY OPERATED EDGE OR SURFACE-MOUNTED FLUSH BOLTS OR SURFACE BOLTS ARE PROHIBITED.

15. APPLICABLE CODES: ALL WORK & MATERIALS SHALL BE IN ACCORDANCE WITH THE CURRENT EDITIONS OF THE GOVERNING CODES AND APPLICABLE STANDARDS.

16. NOTE TO THE GENERAL CONTRACTOR/BUILDER/TRADES: CONTRACTOR IS RESPONSIBLE FOR: DIMENSIONS WHICH SHALL BE CONFIRMED AND CORRELATED AT THE JOB SITE; FABRICATION PROCESSES AND TECHNIQUES OF CONSTRUCTION; COORDINATION OF HIS WORK WITH THAT OF ALL OTHER TRADES; FURNISHING ALL ITEMS REQUIRED FOR THE PROPER EXECUTION, COMPLETION AND SATISFACTORY PERFORMANCE OF ALL WORK NECESSARY, INDICATED, REASONABLY INFERRED OR REQUIRED BY ANY CODE WITH JURISDICTION TO COMPLETE THEIR SCOPE OF WORK FOR A COMPLETE & PROPER FINISHED JOB. IN CASE OF ANY QUESTIONS OR NEED FOR FURTHER CLARIFICATION OF INFORMATION AND/OR DETAILS, CONTRACTOR SHOULD CONTACT THE ARCHITECT PRIOR TO FURTHER CONSTRUCTION OR FABRICATION OF ITEMS IN QUESTION. CONTRACTOR SHALL TAKE DIRECTION FROM DESIGNATED

OWNER'S REPRESENTATIVE. 17. MATERIAL SELECTION: MANUFACTURER, MAKE, MODEL NUMBER, COLOR, ETC., OF FINISH MATERIALS, APPLIANCES, ETC., SHALL BE SELECTED BY

THE OWNER REPRESENTATIVE AND/OR ARCHITECT. 18. SUBSTITUTIONS: NO SUBSTITUTIONS SHALL BE MADE WITHOUT THE OWNER

REP./ARCHITECT'S PRIOR WRITTEN APPROVAL 19. GUARANTEE: THE ARCHITECT MAKES NO EXPRESSED OR IMPLIED GUARANTEE FOR PRODUCTS IDENTIFIED BY TRADE NAME OR

20. JOB CLEAN UP: ALL TRADES SHALL KEEP THE PREMISES FREE FROM ACCUMULATION OF WASTE AND/OR RUBBISH CAUSED BY THEIR WORK. ALL RUBBISH, TOOLS, AND SURPLUS SUPPLIES AND MATERIALS SHALL BE REMOVED AT THE COMPLETION OF THE DAY'S WORK. LEAVE THE JOB IN A BROOM CLEAN CONDITION. PROVIDE DUST CONTROL DAILY.

21. DIMENSIONS: DO NOT SCALE DRAWINGS. WRITTEN DIMENSIONS TAKE PRECEDENCE OVER SCALED DIMENSIONS. ALL DIMENSIONS ARE TO FACE OF STUD OR TO FACE OF FRAMING UNLESS OTHERWISE NOTED. VERIFY ALL FRAMING DIMENSIONS AT CABINETS, ETC., TO INSURE PROPER FIT. ALL DIMENSIONS SHALL BE CONFIRMED AND CORRELATED BY THE CONTRACTOR AT THE JOB SITE. IN CASE OF ANY QUESTIONS, THE CONTRACTOR SHOULD NOTIFY THE ARCHITECT FOR FURTHER CLARIFICATION.

22. SHOP DRAWINGS & CONSULTANT'S DRAWINGS: REFER TO SHOP DRAWINGS AND CONSULTANT'S DRAWINGS FOR FURTHER PROJECT SCOPE AND COORDINATION REQUIREMENTS.

GOVERNING CODES

2017 Pikes Peak Regional Building Code

2009 ICC/ANSI AII7.1 Accessibility Standard

2015 International Fuel Gas Code

2015 International Plumbing Code

2015 International Fire Code

AMENDMENTS PER THEIR ADOPTING ORDINANCES.

2015 International Building Code With amendments

2015 International Mechanical Code with amendments

2014 National Electrical Code/NFPA-70 with amendments

2013 ASME AI7.1 Safety Code for Elevators and Escalators

2011 ASME A17.3 Safety Code for Existing Elevators and Escalators

23. NEW WORK TO BLEND INTO EXISTING. FINISH TO NEAREST CORNER OR BREAK IN MATERIAL TYPE. PROVIDE J-STRIP AT EDGES OF GYP. BD. AGAINST DISSIMILAR MATERIALS. CAULK FOR NEAT APPEARANCE AND TO PREVENT WATER PENETRATION.

ALL CONSTRUCTION SHALL COMPLY WITH THE FOLLOWING CODES AND

2015 International Energy Conservation Code with amendments

PROJECT TEAM

OWNER REPRESENTATIVE: EL PASO COUNTY FACILITIES MANAGEMENT 325 S. CASCADE AVE. COLORADO SPRINGS, CO 80903 PHONE: (719) 520-6573 JILL TRAVIS

ARCHITECT:

TREMMEL DESIGN GROUP, LLC 201 E. LAS ANIMAS STREET, STE. 113 COLORADO SPRINGS, CO 80903 PHONE: 719.623.5641 SHARON ALLEN


STRUCTURAL ENGINEER:

RON BROWN

MGA STRUCTURAL ENGINEERS 115 SOUTH WEBER STREET, SUITE 101 COLORADO SPRINGS, CO 80903 PHONE: 719.635.4473 JON DIETRICH


MECHANICAL/ELECTRICAL/PLUMBING ENGINEER:

51 ENGINEERING CONSULTANTS 2960 N. ACADEMY BLVD., STE. IOI COLORADO SPRINGS, CO 80917 PHONE: 719.368.7394 AARON SPRINGFIELD

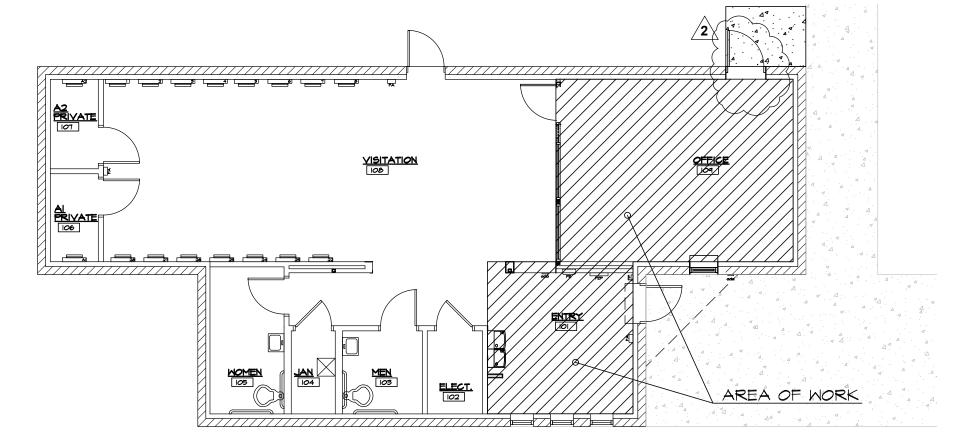

AREA OF WORK REFERENCE PLAN



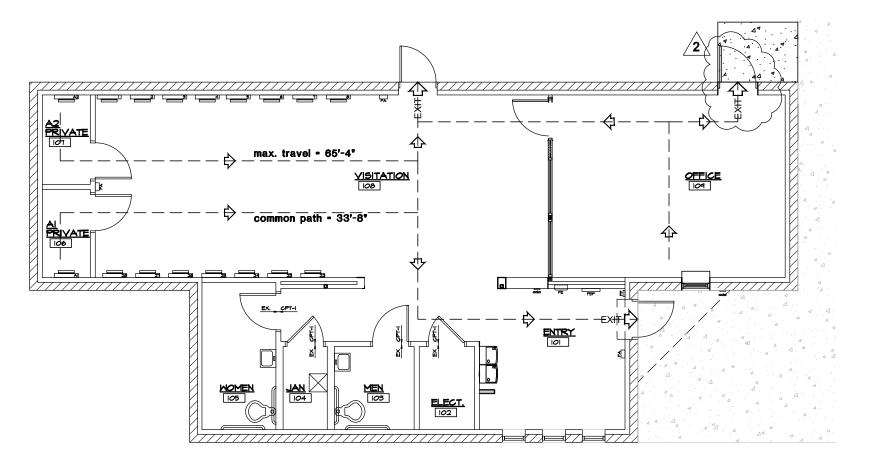

EGRESS PLAN SCALE: 1/8" = 1'-0"





VICINITY MAP NOT TO SCALE

2727 E. LAS VEGAS ST. COLORADO SPRINGS, CO

NO. OF

PROJECT DATA

EL PASO COUNTY 200 S. CASCADE AVENUE COLORADO SPRINGS, CO 80903 PROJECT ADDRESS: JAIL VISITOR CENTER 2727 E. LAS VEGAS STREET COLORADO SPRINGS, CO 80907

PROJECT DESCRIPTION: THE PROJECT IS AN INTERIOR OFFICE REMODEL INCLOSING AN OFFICE. IT ALSO INCLUDES EXTERIOR WORK TO ADD A DOOR AND WINDOW. INCLUDES STRUCTURAL, MECHANICAL AND ELECTRICAL WORK

ASSESSOR'S SCHEDULE NO. 6433401001

LEGAL DESCRIPTION: LOT 2 BLK | HASSLER + BATES SUB NO 3

CITY ZONING CLASSIFICATION:

EXISTING CONSTRUCTION TYPE: V-B) NOT SPRINKLERED EXISTING BUILDING OCCUPANCY: B - OFFICE

NUMBER OF STORIES: I STORY

EXISTING BUILDING HEIGHT:

13'-6"

EXISTING BUILDING AREA: 1,582 SF B BUSINESS

AREA OF REMODEL: 474 SF. EXISTING:

LOAD OCC. 1,582 SF 1/100 16 000 B, BUSINESS

NEM:

B, BUSINESS 1,582 SF 1/100 16 OCC

REMODEL DOES NOT CHANGE OCCUPANT LOAD

REMODEL DOES NOT CHANGE EXIT REQUIREMENTS. REMODEL DOES NOT CHANGE FIRE REQUIREMENTS.

REMODEL DOES NOT CHANGE PLUMBING FIXTURE REQUIREMENTS

SHEET INDEX

M-601

COVER SHEET, PROJECT DATA ARCHITECTURAL GENERAL SPECIFICATIONS DEMOLITION FLOOR PLAN, CONSTRUCTION FLOOR PLAN, DETAILS DEMOLITION RCP, CONSTRUCTION RCP, DETAILS Al.l ENLARGED PLAN, SECTION, SCHEDULES A2.0 A5.0 DETAILS

MECHANICAL SCHEDULES AND CALCULATIONS

M-001 MECHANICAL LEGEND, NOTES AND SPECIFICATIONS MECHANICAL HVAC DEMOLITION PLAN MECHANICAL HVAC NEW WORK PLAN MECHANICAL DETAILS M-501

PLUMBING LEGEND, NOTES AND SPECIFICATIONS P-001 PLUMBING WATER DEMOLITION PLAN PD-W-101 PLUMBING WATER NEW WORK PLAN P-W-101

PLUMBING SCHEDULES AND CALCULATIONS P-601 ELECTRICAL LEGENDS, NOTES AND SPECIFICATIONS E-001 ELECTRICAL LIGHTING DEMOLITION PLAN ED-L-IOI ELECTRICAL POWER DEMOLITION PLAN

ELECTRICAL EXISTING ONE LINE DIAGRAM

ELECTRICAL LIGHTING NEW WORK PLAN E-L-101 ELECTRICAL POWER NEW WORK PLAN E-P-IOI ELECTRICAL IECC CALCULATIONS E-601 ELECTRICAL PANEL SCHEDULES AND CALCULATIONS E-602

09/29/22 Owner Re

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DATE FOR

12/13/21 | RBD REV

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VICINITY MAP PROJECT DATA SHEET INDEX

DATE: 11/24/21 DRAWN BY: tdg

CHECKED BY: TDG PROJECT NO: 21142

SHEET NO:

GENERAL DEMOLITION NOTES:

- I. CONTRACTOR SHALL VERIFY ALL DIMENSIONS AND CONDITIONS ON THE SITE AND NOTIFY ARCHITECT OF ANY DISCREPANCIES PRIOR TO STARTING ANY WORK OR WHEN DISCREPANCIES REVEAL THEMSELVES.
- 2. ALL ELECTRICAL/TELEPHONE CONDUIT AND/OR PLUMBING WITHIN DEMOLISHED PARTITIONS AND/OR MILLWORK SHALL BE REMOVED TO THE POINT OF ORIGIN OR TERMINATED OR REMOVED UP TO A POINT REQUIRED FOR INTERFACE WITH NEW CONSTRUCTION. CONDUIT AND/OR PLUMBING SHALL NOT BE EXPOSED IN EITHER NEW OR EXISTING CONSTRUCTION.
- 3. ALL WALLS NOTED TO BE REMOVED SHALL BE FULLY REMOVED. NO PONY WALLS ABOVE CEILING (U.N.O.) RE-ATTACHED/RELOCATE ANY ITEMS TO REMAIN WHICH MAY HAVE BEEN ATTACHED TO WALL
- 4. PATCH AND REPAIR EXISTING CONSTRUCTION /
- FINISHES. PREPARE FOR NEW FINISHES AS REQUIRED. 5. CONTRACTOR TO VERIFY DISPOSAL OR STORAGE OF REMOVED EQUIPMENT SUCH AS APPLIANCES. PLUMBING FIXTURES, ETC. WITH OWNER.

GENERAL CONSTRUCTION NOTES.

- I. THE CONTRACTOR SHALL SUPERVISE AND DIRECT THE WORK USING HIS/HER BEST SKILLS AND ATTENTION. THE CONTRACTOR SHALL BE SOLELY RESPONSIBLE FOR ALL CONSTRUCTION MEANS, METHODS, TECHNIQUES, SEQUENCES AND PROCEDURES AND FOR COORDINATING ALL PORTIONS
- OF THE WORK UNDER CONTRACT. 2. THE CONTRACTOR SHALL VERIFY ALL DIMENSIONS AND EXISTING CONDITIONS ON THE SITE AND NOTIFY ARCHITECT OF ANY DISCREPANCIES IN WRITING BEFORE STARTING ANY
- 3. PROVIDE NONCOMBUSTIBLE, FIRE RETARDANT TREATED WOOD BLOCKING IN WALLS AS REQUIRED FOR WALL MOUNTED MILLWORK, PANELS, EQUIPMENT, ACCESSORIES, SHELVING, WALL STOPS, AND FURNITURE. VERIFY LOCATION
- WITH FURNITURE VENDOR. 4. VERIFY AVAILABILITY OF MATERIALS TO BE USED FROM BUILDING STOCK W/ BUILDING MANAGEMENT, IF APPLICABLE
- 5. CONTRACTOR SHALL FIELD MEASURE EXISTING CONDITIONS PRIOR TO ORDERING, FABRICATING OR PERFORMING ANY NEW WORK. DEVIATIONS FROM CONDITIONS SHOWN ON THESE DRAWINGS SHALL BE REPORTED TO THE ARCHITECT. DIFFERING SITE CONDITIONS FROM THOSE ON THE PLANS WILL GENERALLY NOT BE CONSIDERED A BASIS FOR CONTRACT MODIFICATIONS. THE CONTRACTOR SHALL ALLOW FOR WORST CASE SITE CONDITIONS WHENEVER POSSIBLE.
- 6. ALL ADHESIVE USED IN CONSTRUCTING NEW FACILITY TO BE NON-TOXIC AND ENVIRONMENTALLY SAFE.
- 7. MAINTAIN ONE SET OF RED LINE AS-BUILT DRAWINGS AT THE JOB SITE AND SUBMIT TO THE ARCHITECT AT THE COMPLETION OF THE WORK.

BALLISTIC SPECIFICATIONS

APPROVED EQUAL SUBSTITUTIONS PERMITTED. SUBSTITUTION REQUESTS PER CSI FORMAT.

WALLS -LEVEL III RATING BY ARMORCORE BULLET RESISTANT FIBERGLASS PANELS. INSTALL PER MANUF. REQUIREMENTS. VERIFY W/ EPC FOR FINAL PRODUCT. EPC HAS SURPLUS BOARD TO BE USED IN THIS PROJECT. COORDINATE WITH EPC FOR FINAL PRODUCT AND AMOUNTS PRIOR TO BID.

DOOR AND FRAMES -LEVEL III BULLET RATING BY COVENANT SECURITY

EQUIPMENT REAR DOOR TO BE H.M. W. SLIM VISION PANEL. PRIMED TO RECEIVE PAINT. CSE-ATX-M-SL-3684-L3 INTERIOR DOOR TO BE HOLLOW METAL, NO LIGHT. CSE-ATX-M-NL-3684-L3


INSTALL PER MANUF. REQUIREMENTS.


MINDOWS -LEVEL III RATED GLASS AND FRAME BY NORTH AMERICAN BULLET PROOF. (NO GLASS POLYCARBONATE). STEEL FRAME, INSTALL PER MANUF. REQUIREMENTS.

TRANSACTION WINDOW STATION - LEVEL III BULLET RESISTANT RATING BY COVENANT SECURITY EQUIPMENT, WALK-UP TRANSACTION WINDOW STATION 27-1/2" (W) $\times 49-1/4"$ (H) CSE QS-TS-625-MINI STAINLESS STEEL WITH BUILT-IN INTERCOM INSTALL PRE MANUF. REQUIREMENTS.

INTERCOM SPECIFICATIONS

NORCON COMMUNICATIONS TTU-3x-ADA WITH ADDITIONAL OPTIONS: WIRELESS - ? PUSH TO TALK - ? MONITORING AND RECORDING - ? CUSTOMIZED HEADSET - ?

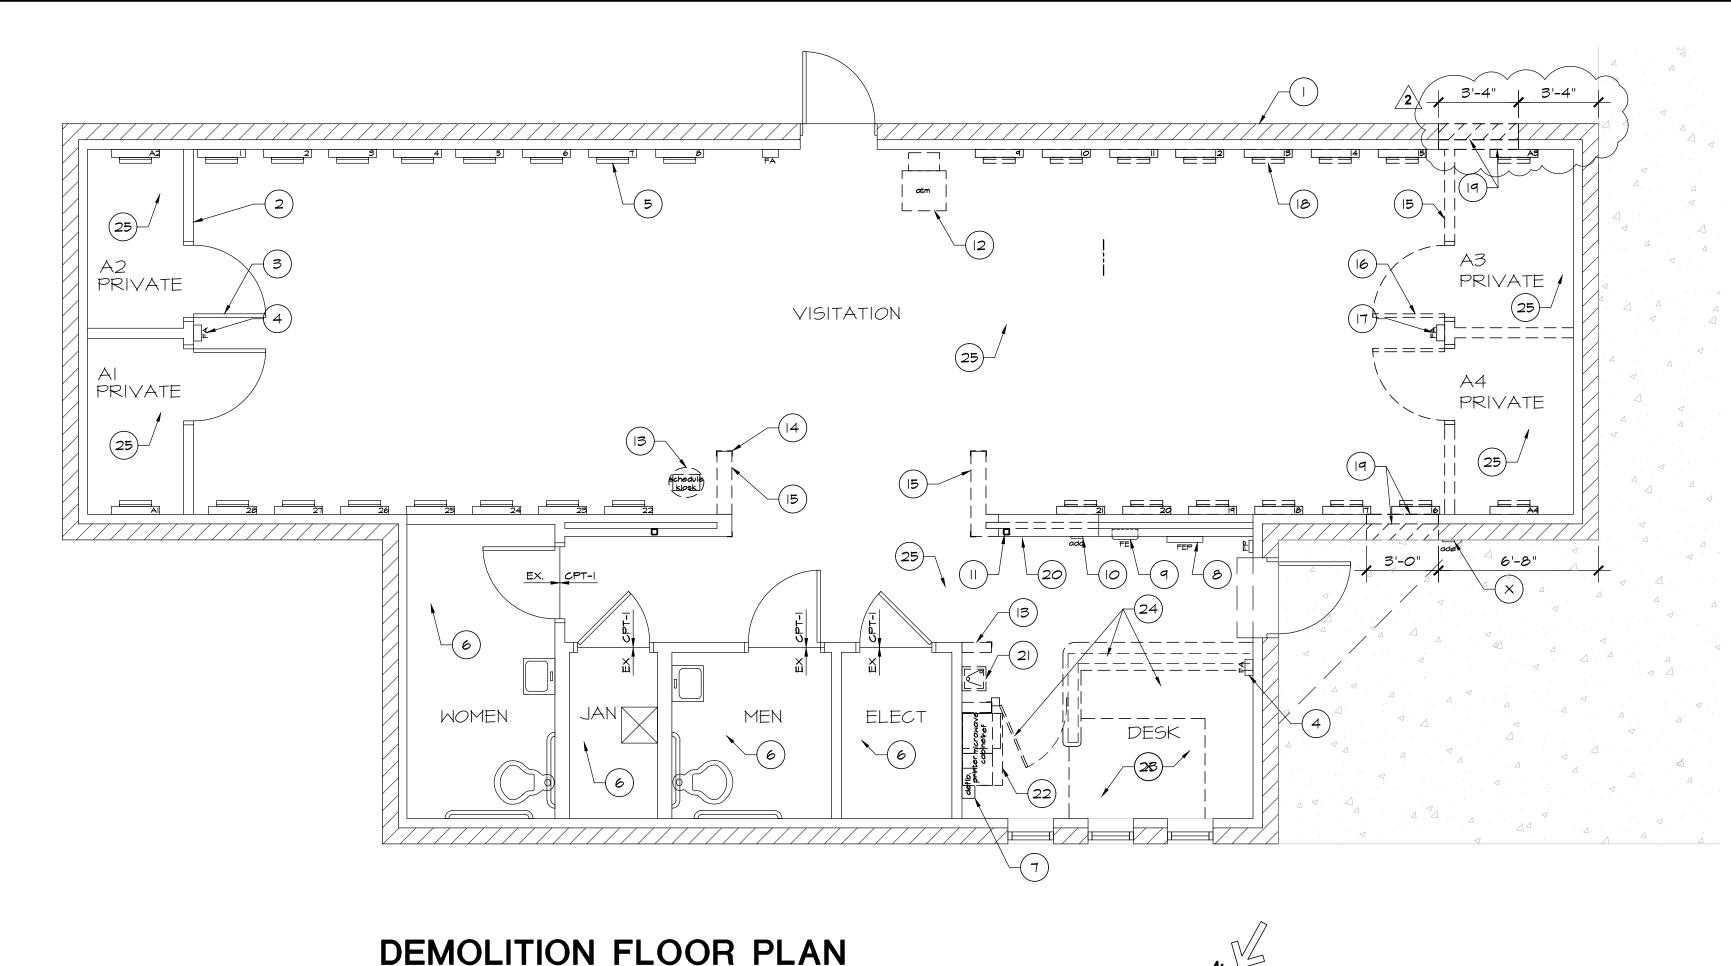

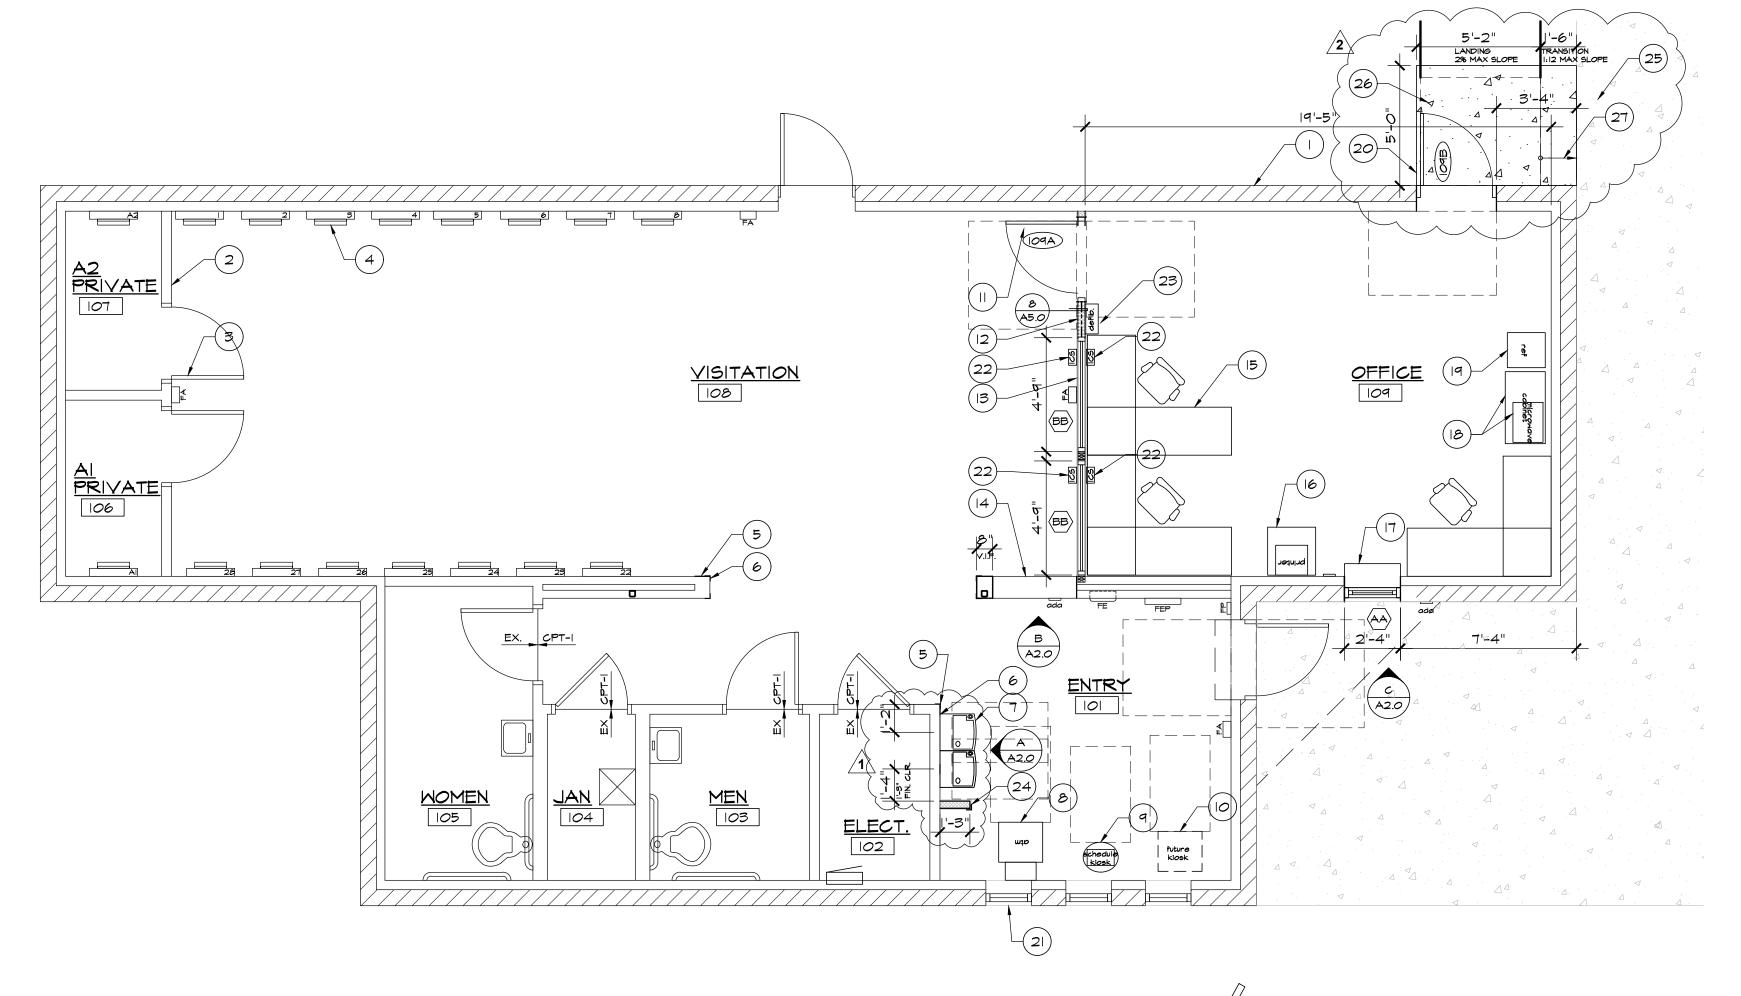

CONSTRUCTION FLOOR PLAN SCALE: 1/4"=1'-0"

SCALE: 1/4"=1'-0"



DEMOLITION FLOOR PLAN NOTES

- EXISTING EXTERIOR MASONRY WALL TO REMAIN,
- SHOWN SOLID, TYP
- 2. EXISTING INTERIOR GYPSUM BOARD WALL TO REMAIN, SHOWN SOLID, TYP.
- 3. EXISTING DOOR TO REMAIN, SHOWN SOLID, TYP. 4. EXISTING FIRE ALARM TO REMAIN, TYP.
- 5. EXISTING VIDEO MONITOR, SHOWN SOLID TYP.
- 6. NO WORK THIS AREA
- EXISTING DEFIBRILLATOR KIT TO BE RELOCATED, TYP. 8. EXISTING FIRE PANEL TO REMAIN, TYP.
- 9. EXISTING FIRE EXTINGUISHER CABINET TO REMAIN, TYP. IO. EXISTING ADA DOOR OPENER TO REMAIN, TYP.
- II. EXISTING COLUMN TO REMAIN, TYP. 12. EXISTING ATM TO BE RELOCATED. PROTECT DURING CONSTRUCTION. COORDINATE WITH EPC FOR FINAL
- LOCATION. 13. EXISTING SCHEDULING KIOSK TO BE RELOCATED. PROTECT DURING CONSTRUCTION. COORDINATE WITH
- EPC FOR FINAL LOCATION. 14. EXISTING CORNER GUARDS TO BE SALVAGED FOR
- REUSE, TYP. 15. EXISTING INTERIOR WALL TO BE REMOVED, SHOWN
- DASHED, TYP. 16. EXISTING DOOR TO BE REMOVED, SHOWN DASHED, TYP.
- RETURN TO OWNER. 17. EXISTING FIRE ALARM TO BE RELOCATED PER NFPA
- REQUIREMENTS. 18. EXISTING VIDEO MONITOR TO BE REMOVED FOR
- SALVAGE, RETURN TO OWNER, TYP. 19. EXISTING MASONRY AND FURRING WALL TO BE
- REMOVED FOR NEW OPENING. SEE DETAIL FOR STRUCT. 20. NEW OPENING IN EXISTING WALL. SEE INT. ELEV.
- 21. EXISTING DRINKING FOUNTAIN TO BE REMOVED. 22. EXISTING EPC CABINET, MICROWAVE AND REFRIGERATOR TO BE RELOCATED. PROTECT DURING CONSTRUCTION. COORDINATE WITH EPC FOR FINAL
- LOCATIONS. 23. EXISTING RAISE FLOOR TO BE REMOVED. PREP. FLOOR FOR NEW FINISH.
- 24. EXISTING PARTIAL HEIGHT WALL, COUNTER, WORK SURFACE, AND GATE TO BE REMOVED.
- 25. REMOVE EXISTING CARPET. PREP FLOOR FOR NEW CARPET.

CONSTRUCTION FLOOR PLAN NOTES

- EXISTING EXTERIOR MASONRY WALL TO REMAIN, TYP. EXISTING INTERIOR GYP BD. WALL TO REMAIN, TYP.
- EXISTING DOOR TO REMAIN, TYP. 4. EXISTING VIDEO MONITOR TO REMAIN, TYP.
- 5. RELOCATED CORNER GUARD, TYP. 6. PATCH AND REPAIR EXISTING WALL FROM DEMO AND NEW CONSTRUCTION. MATCH EXISTING GYP. TEXTURE AND FINISH.
- 7. NEW HI/LO DRINKING FOUNTAIN, SEE INTERIOR ELEVATION. SEE PLUMBING.
- 8. RELOCATED ATM MACHINE. VERIFY FINAL LOCATION
- 9. RELOCATED SCHEDULING KIOSK. VERIFY FINAL
- LOCATION WITH EPC. IO. NEW KIOSK. VERIFY WITH EPC.
- II. NEW LEVEL III BALLISTIC DOOR.

 12. NEW LEVEL III BALLISTIC WALL TO UNDERSIDE OF
- STRUCTURE. SEE DETAIL.
- 13. NEW LEVEL III BALLISTIC WINDOWS 14. NEW GYP. BD. OPENING IN WALL W/ PAINTED WOOD CAP
- 4'-2" AFF ABOVE ADA PUSH BUTTON. SEE ELEVATION 15. FURNITURE PER EPC. 16. CABINET WITH PRINTER PER EPC
- 17. NEW LEVEL III BALLISTIC TRANSACTION WINDOW IN NEW OPENING IN WALL. PATCH AND REPAIR WALL FROM DEMO AND NEW CONSTRUCTION. MATCH EXISTING GYP. TEXTURE AND FINISH.
- 18. RELOCATED EPC MICROWAVE ON CABINET. VERIFY
- WITH EPC 19. RELOCATED REFRIGERATOR. COORDINATE WITH EPC. 20. NEW LEVEL III BALLISTIC H.M. DOOR.
- 21. EXISTING WINDOWS, TYP. 22. NEW WIFI INTERCOM SYSTEM, ONE PER DESK LOCATION. 2 TOTAL COORD WITH EPC FOR FINAL LOCATION.
- 23. NEW LOCATION FOR DEFIBRILLATOR KIT. 124 NEW PARTIAL HT WING WALL W/ PTD. WOOD CAP TO ~ 4'-2" AFF.
- 25. EXISTING CONC. SIDEWALK TO REMAIN, TYP
- \$ 26. \NEW CONC, SLAB ON GRADE LANDING, 2% SLOPE MAX. 27. CONC. SLAB ON GRADE, TRANSITION BETWEEN LANDING AND EXISTING CONCRETE. MAX. SLOPE 1:12

WALL LEGEND

EXISTING EXTERIOR WALLS TO REMAIN

ETTT EXISTING INTERIOR WALLS TO BE

EXISTING INTERIOR WALLS TO REMAIN

REMOVED. 3-5/8" MTL WD STUDS @ 16" OC. W/ (1)

LAYER OF 5/8" GYP. BD. O/ LEVEL III BULLET RESISTANT PANEL TO UNDERSIDE OF STRUCTURE W/ 5/8" GYP. BD. OTHER SIDE WITH W/ SOUND BATT INSULATION. SEE DET. 8/A5.0.


ALL DIMENSIONS ARE FROM FACE OF STUD FOR NEW CONSTRUCTION OR FACE OF EXISTING FINISH AT EXISTING CONDITIONS.

USE WATER RESISTANT 5/8" GYP. BD. AT ALL WET LOCATIONS.

RBD

DATE FOR 12/13/21 RBD REV 09/29/22 Owner Re

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CONSTRUCTION FLOOR

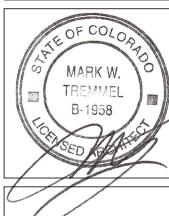DEMOLITION FLOOR PLAN

DATE: 11/24/21 DRAWN BY: tdg **CHECKED BY: TDG**

PROJECT NO: 21142 SHEET NO:

GENERAL RCP NOTES

- I. EXISTING LIGHT FIXTURES, MECHANICAL SUPPLY AND RETURNS TO BE REUSED WHERE POSSIBLE. CLEAN SUPPLY AND RETURN AIR GRILLS TO LIKE NEW CONDITION IN ROOMS AFFECTED BY REMODEL
- 2. MAINTAIN FIRE PROTECTION DEVICES, INCLUDING SMOKE DETECTORS, FIRE ALARMS, ALARM SPEAKERS, ADA STROBES, ETC. INCLUDE COSTS TO TIE SUCH DEVICES INTO BUILDING PANEL. VERIFY REQUIREMENTS AND QUANTITIES OF EACH DEVICE. GC TO CONTRACT AND COORDINATE
- 3. BALANCE HVAC AS REQUIRED FOR NEW LAYOUT. PER MECHANICAL PLANS. PROVIDE TEST AND
- BALANCE TO MECHANICAL ENGINEER. 4. RECONFIGURE SPRINKLER SYSTEM FOR NEW ROOM AS REQUIRED BY NFPA GUIDELINES AND CURRENT FIRE CODES. NEW SPRINKLER HEADS TO MATCH
- EXISTING SPRINKLER HEADS. 5. SEE ELECTRICAL PLANS FOR ADDITIONAL
- INFORMATION. 6. SEE MECHANICAL PLANS FOR ADDITIONAL
- INFORMATION. 7. PROVIDE COORDINATION BETWEEN LIGHTING, MECHANICAL DUCTWORK AND EXISTING BEAMS PRIOR TO CONSTRUCTION. DUCTWORK TO BE HELD TIGHT TO UNDERSIDE OF DECKING WHERE POSSIBLE AND TIGHT TO BEAMS.

RCP SYMBOLS LEGEND

EXISTING 2x4 FLUOR. FIXTURE TO BE RELOCATED OR RETURNED TO OWNER



EXISTING 2x2 FLUOR. FIXTURE TO RELOCATED OR RETURNED TO OWNER

EXISTING AIR SUPPLY TO BE RELOCATED OR RETURNED TO OWNER



EXISTING AIR RETURN TO BE RELOCATED OR RETURNED TO OWNER



EXISTING AIR RETURN TO BE RELOCATED OR RETURNED TO OWNER

EXISTING 2×4. FIXTURE TO



EXISTING 2x2 FLUOR. FIXTURE TO REMAIN.

REMAIN.




EXISTING AIR SUPPLY TO REMAIN



EXISTING AIR RETURN TO REMAIN



EXISTING AIR RETURN TO REMAIN

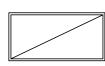

NEW OR RELOCATED FLUOR. LIGHT FIXTURE



EXISTING 2x2 FLUOR. FIXTURE TO REMAIN.



SUPPLY


NEW OR RELOCATED AIR

RETURN TO REMAIN

NEW OR RELOCATED AIR




R = REUSE/RELOCATE N = NEW

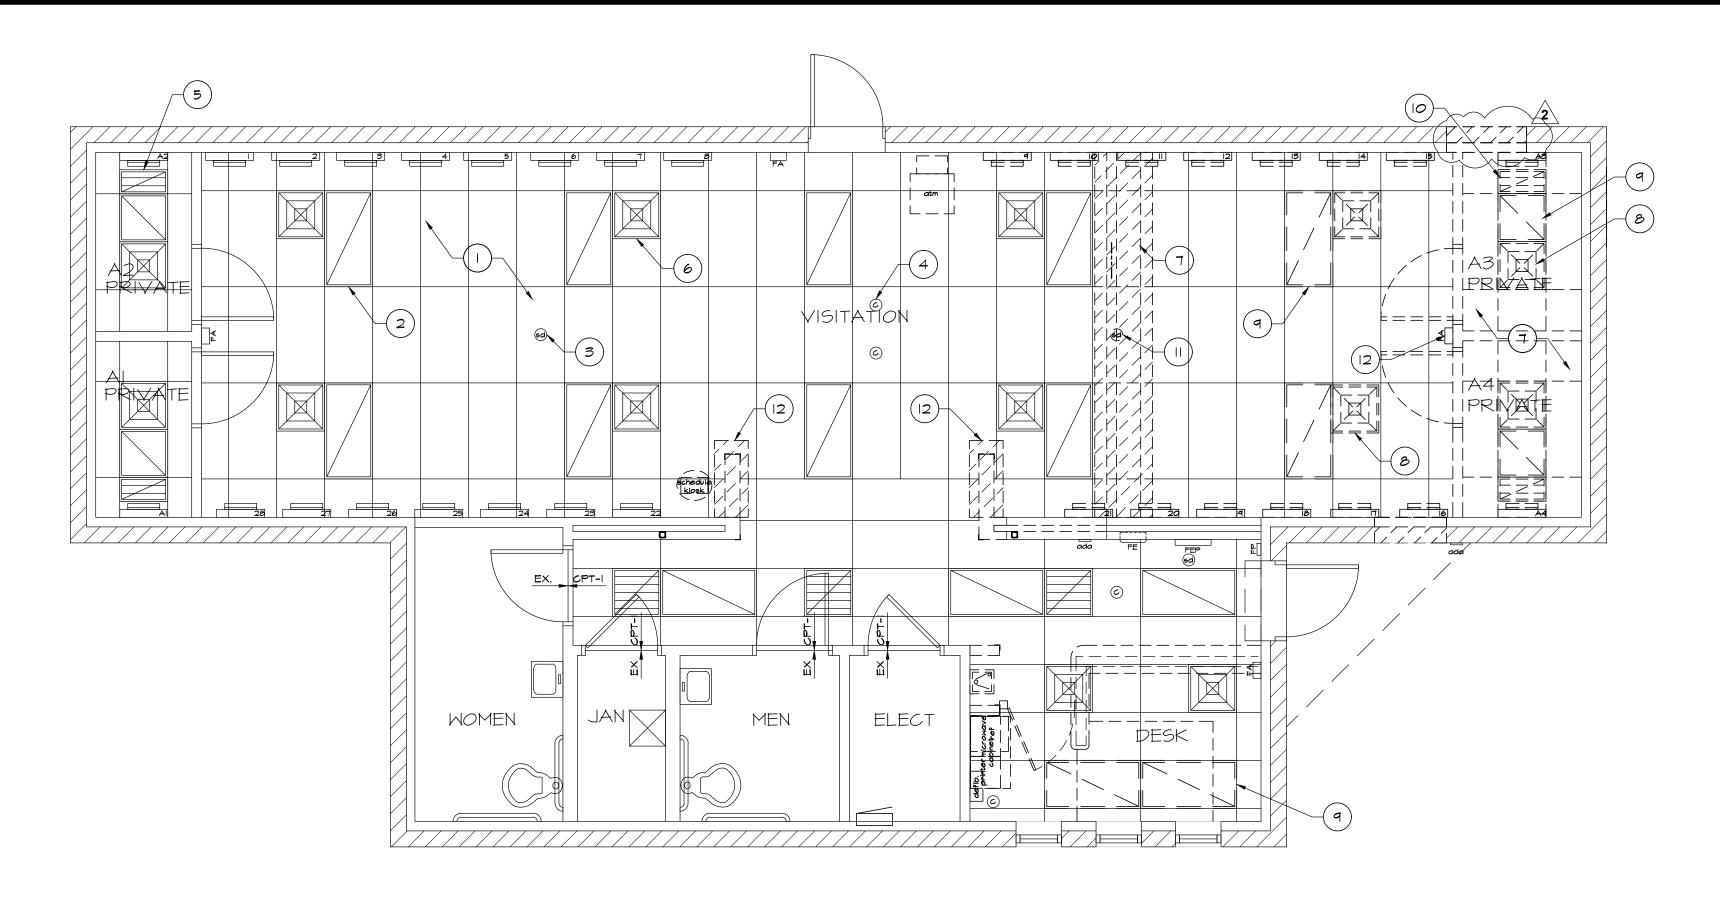

DEMOLITION REFLECTED CEILING PLAN SCALE: 1/4"=1'-0"



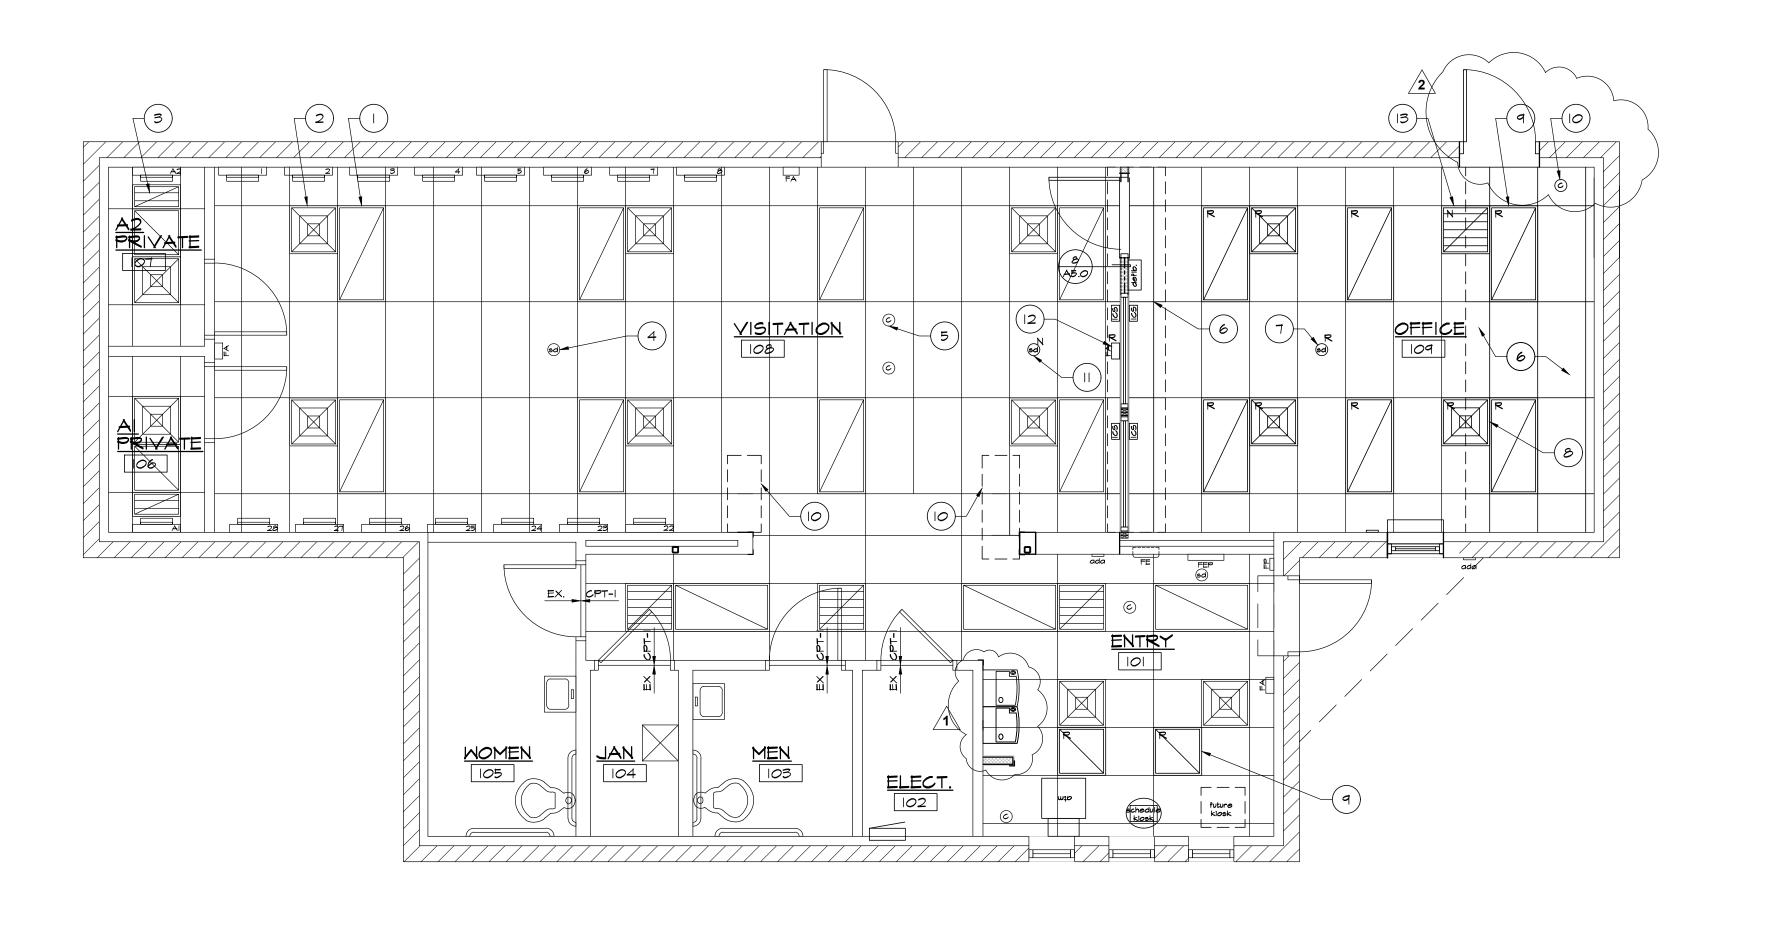

CONSTRUCTION REFLECTED CEILING PLAN SCALE: 1/4"=1'-0"



DEMO. REF. CLG. PLAN NOTES

- EXISTING ACOUSTIC CEILING GRID SYSTEM TO
- REMAIN, TYP. 2. EXISTING LIGHT TO REMAIN, TYP.
- 3. EXISTING CEILING SMOKE DETECTOR TO REMAIN,
- 4. EXISTING CAMERA TO REMAIN, TYP.
- 5. EXISTING RETURN AIR GRILLE TO REMAIN, TYP. 6. EXISTING AIR SUPPLY TO REMAIN, TYP. 7. CEILING GRID TO REMOVED FOR NEW
- CONSTRUCTION. SALVAGE TILES FOR REUSE, TYP. 8. EXISTING AIR SUPPLY TO BE RELOCATED, SEE
- MECHANICAL, TYP. 9. EXISTING LIGHT TO BE RELOCATED, SEE ELECT.
- IO. EXISTING RETURN AIR GRILLE TO BE RELOCATED
- OR REMOVED, SEE MECHANICAL.
- II. EXISTING CEILING MOUNTED SMOKE DETECTOR TO BE RELOCATED.
- 12. MODIFY EXISTING CEILING GRID SYSTEM FOR DEMO OF WING WALL, TYP. PATCH AND REPAIR FOR CONSISTENT GRIDS AND FULL TILES.

CONST. REF. CLG. PLAN NOTES

- -(I.) Existing light fixture to remain, typ.
- 2. EXISTING AIR SUPPLY GRILLE. TYP. CLEAN TO LIKE NEW CONDITION
- 3. EXISTING AIR RETURN GRILLE, TYP. CLEAN TO LIKE NEW CONDITION.
- 4. EXISTING CEILING MOUNTED SMOKE
- DETECTOR, TYP. 5. EXISTING CEILING MOUNTED CAMERAS,
- 6. PATCH AND REPAIR AND INFILL EXISTING
- CEILING GRID SYSTEM AND TILES TO MATCH EXISTING, TYP. 7. RELOCATED CEILING MOUNTED SMOKE DETECTOR. VERIFY REQUIREMENTS PER
- NFPA. TIE INTO EXISTING FIRE ALARM SYSTEM. 8. RELOCATED AIR SUPPLY GRILLE, SEE
- MECHANICAL. CLEAN TO LIKE NEW CONDITION, TYP. 9. RELOCATED LIGHT FIXTURE, SEE
- ELECTRICAL. CLEAN TO LIKE NEW CONDITION, TYP. 10. PATCH AND REPAIR CEILING GRID SYSTEM
- AND TILES TO MATCH EXISTING FROM DEMOLITION. II. NEW CEILING MOUNTED SMOKE DETECTOR.
- VERIFY REQUIREMENTS PER NFPA. TIE INTO EXISTING FIRE ALARM SYSTEM.
- 12. RELOCATED FIRE ALARM PER NFPA. TIE INTO EXISTING FIRE ALARM SYSTEM. 13. RELOCATED AIR RETURN, SEE MECHANICAL

WALL LEGEND

EXISTING EXTERIOR WALLS TO

REMOVED.

EXISTING INTERIOR WALLS TO REMAIN ₹===3 EXISTING INTERIOR WALLS TO BE

3-5/8" MTL WD STUDS @ 16" OC. W/ (1) LAYER OF 5/8" GYP. BD. O/ LEVEL III BULLET RESISTANT PANEL TO UNDERSIDE OF STRUCTURE W/ 5/8" GYP. BD. OTHER SIDE WITH W/ SOUND BATT INSULATION. SEE DET. 8/A5.0.

ALL DIMENSIONS ARE FROM FACE OF STUD FOR NEW CONSTRUCTION OR FACE OF EXISTING FINISH AT EXISTING CONDITIONS.

USE WATER RESISTANT 5/8" GYP. BD. AT ALL WET LOCATIONS.

CHECKED BY: TDG PROJECT NO: 21142

REVISIONS

DATE FOR

12/13/21 RBD REV

09/29/22 Owner Re

MARK W.

B-1958

Archite

SO

ASO COUNTY VISITOR CENTER

DEMOLITION REF. CLG.

CONSTRUCTION REF.

CLG. PLAN

DATE: 11/24/21

DRAWN BY: tdg

SHEET NO: